McDAVID ENGINEERING MECHANICAL & ELECTRICAL ENGINEERING CONSULTANTS

HARRISONBURG, VIRGINIA 22801 e-mail: fred@fastaz.net

NOTES:

ELECTRICAL CONTRACTOR SHALL DESIGNATE AT LEAST TWO METHODS OF GROUNDING AS REQUIRED BY ART. 250 OF THE N.E.C. VERIFY APPROVAL OF ELECTRICAL INSPECTOR PRIOR TO COMMENCING WORK.

BRANCH CIRCUIT WIRING. FIELD VERIFY LOCATION OF EACH OUTLET, WITH OWNER, PRIOR TO ROUGH-IN.

VERIFY LOCATIONS OF RECEPTACLES, SWITCHES AND TELEPHONE/DATA OUTLETS PRIOR TO INSTALLATION OF

VERIFY AVAILABLE FAULT CURRENT PRIOR TO ORDERING ELECTRIC GEAR.

FEEDER CONDUCTOR SIZES SHOWN ARE COPPER.

APPROPRIATE CONDUIT SIZE.

EQUIVALENT CAPACITY ALUMINUM MAY BE USED WITH

WORK SHALL COMPLY WITH VIRGINIA UNIFORM STATEWIDE BUILDING CODE AND NEC.

JOHN J. BURGER, P.C ARCHITECT FREDERICKSBURG, VIRGINIA

RETAIL FACILITY LADY'S CENTRE RETAIL

> POWER PLAN PANEL SCHEDULE AND RISER DIAGRAM


310NS:

REVISIONS 11 DEC 06


JOB NO.: 0607 SHEET NO.:

E-1


13 OF 14 SHEETS

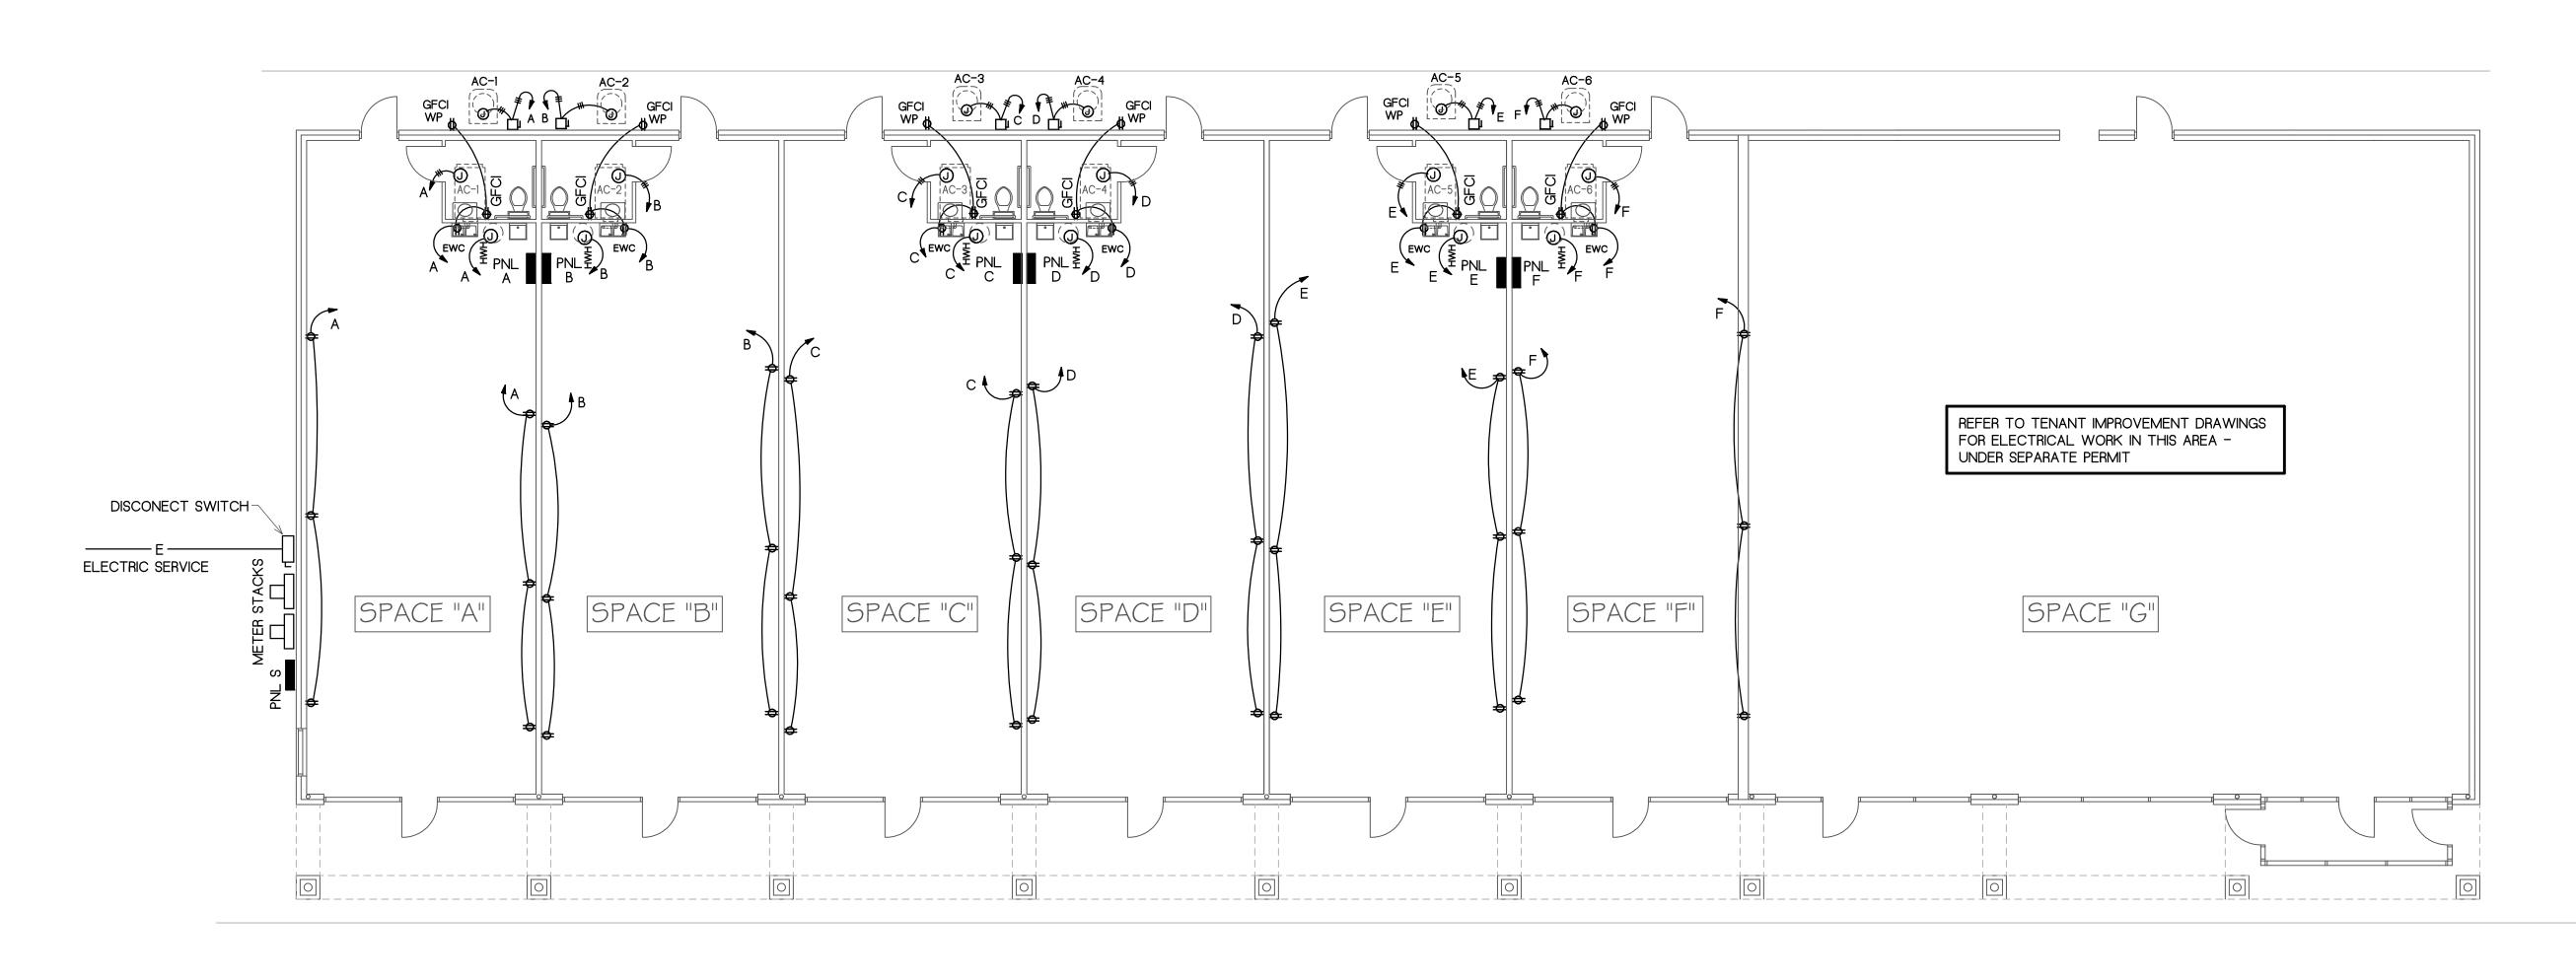

POWER FLOOR PLAN SCALE: 1/8" = 1' - 0"

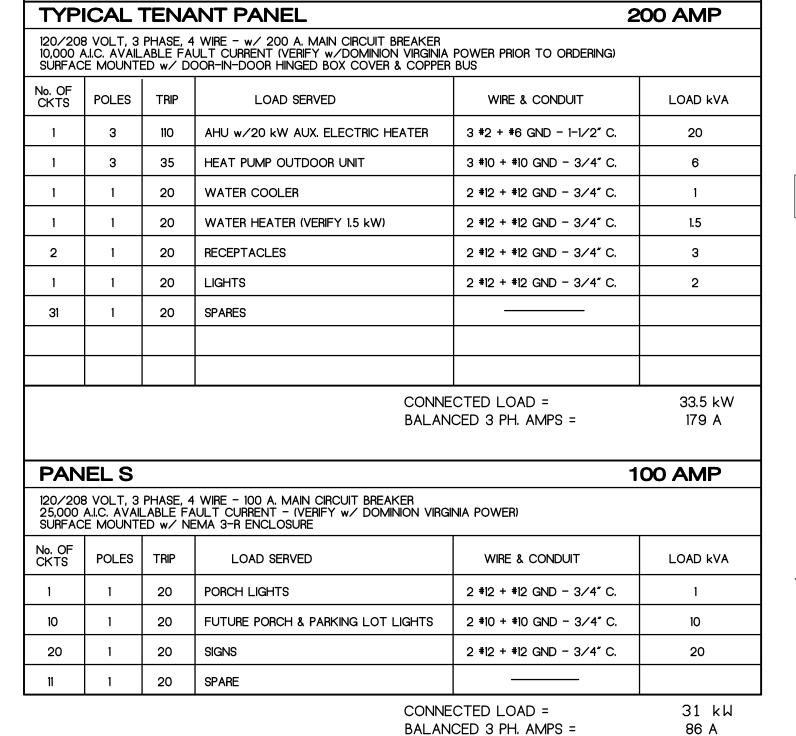

PANEL SCHEDULES

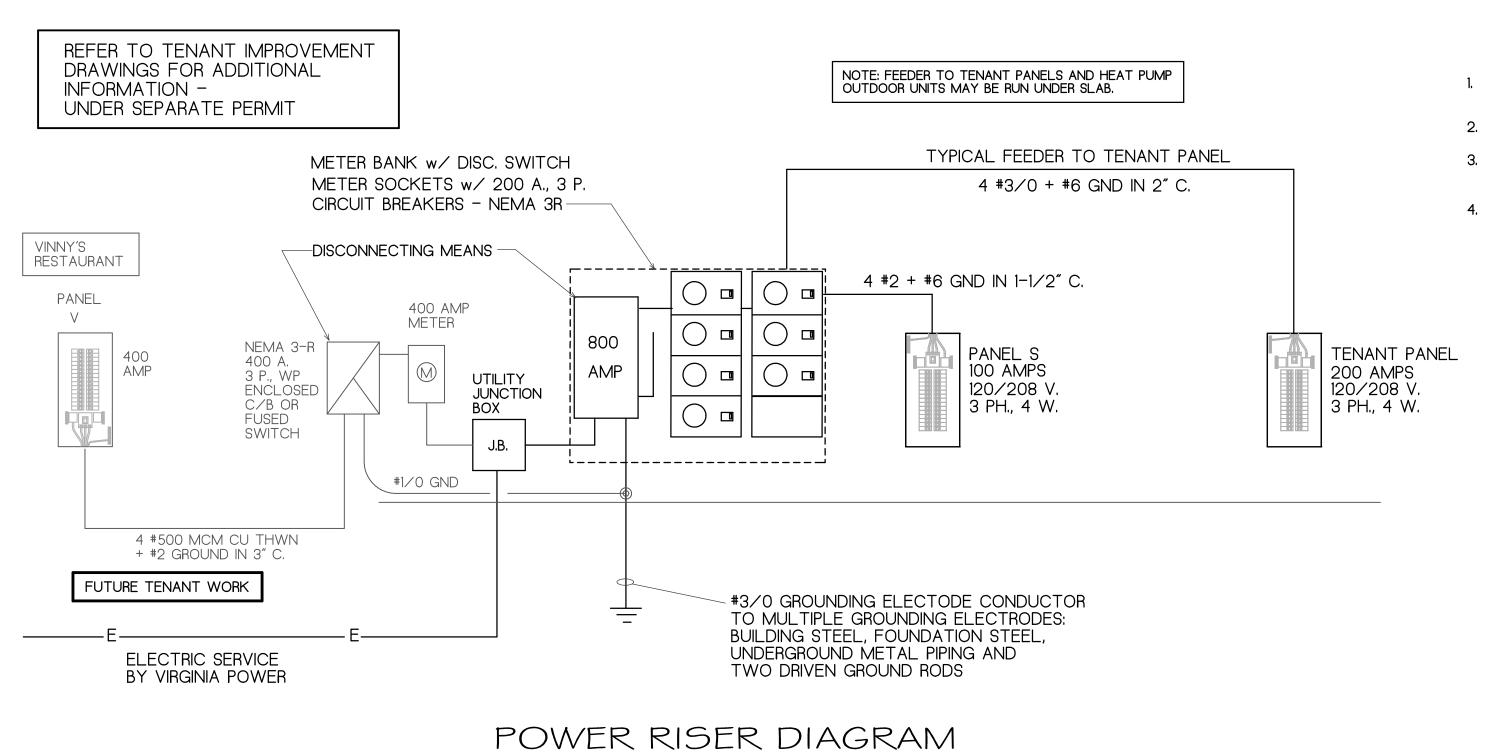

NOT TO SCALE